

DEPARTMENT OF LAND AND NATURAL RESOURCES ENGINEERING DIVISION

FOR


DIVISION OF STATE PARKS

JOB NO. J00CF34B

LAVA TREE STATE MONUMENT TRAIL IMPROVEMENTS

PAHOA, HAWAII COUNTY, HAWAII TMK: (3) 1-4-001:004

VICINITY MAP

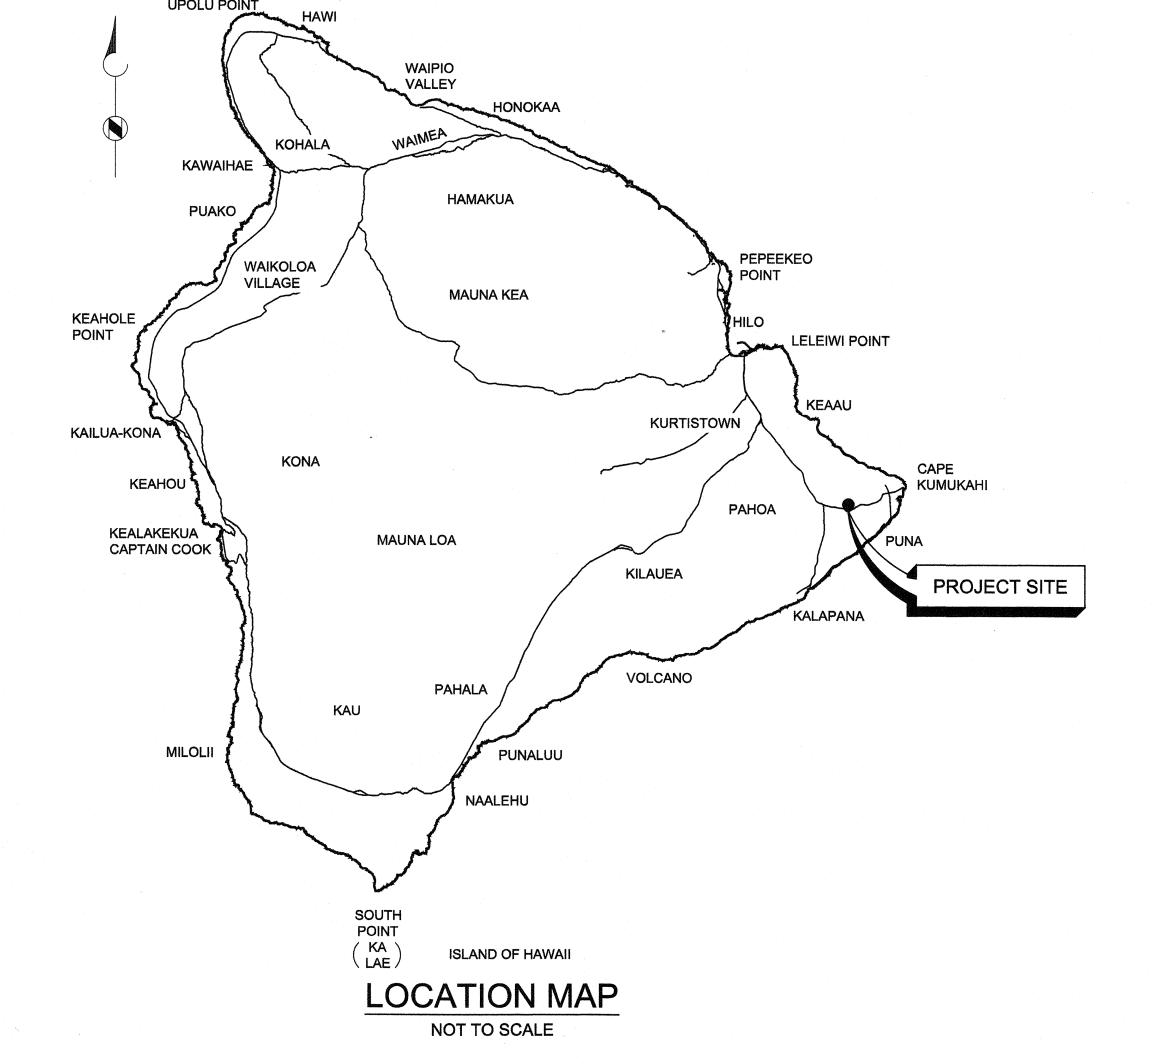

INDEX OF DRAWINGS

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APPROVED:

CURT A. COTTRELL

5.6.16

ADMINISTRATOR
DIVISION OF STATE PARKS
DEPARTMENT OF LAND AND

DEPARTMENT OF LAND AND NATURAL RESOURCES

APPROVED:

CARTY S CHANG, P.E. CHIEF ENGINEER ENGINEERING DIVISION

DATE

ENGINEERING DIVISION
DEPARTMENT OF LAND AND NATURAL RESOURCES

T-1

JOB NO. J00CF34B

SHEET NO. 1 OF 14 SHEETS

		ABBREVIATIONS				LEGEND
	<u>G</u>		<u>P</u>			
S ABSOLUTE	G	GAS OR GATE	P	POLE, PAGE OR PIPE	&	AND
ASPHALT CONCRETE	GAL GALV	GALLON GALVANIZED	PAVT PE	PAVEMENT POLYETHYLENE	#	POUND; NUMBER
AMERICAN CONCRETE INSTITUTE AREA DRAIN	GASCO	THE GAS COMPANY	PL	PROPERTY LINE, PLAIN END	\wedge	CLIDVEY CONTROL DOINT
A AMERICANS WITH DISABILITIES ACT	GEN GND	GENERAL OR GENERATOR GROUND	PRESS PRV	PRESSURE PRESSURE REDUCING VALVE	<u>⟨</u> •\	SURVEY CONTROL POINT
AAG AMERICANS WITH DISABILITIES ACT ACCESSIBILITY GUIDELINES	GP	GUARD POST, GUY POLE, OR GATE POST	PRV PSF PSI	POUNDS PER SQUARE FOOT POUNDS PER SQUARE INCH	FG =630.00	FINISH GRADE SPOT ELEVATION
PROX APPROXIMATE CH ARCHITECTURAL	GPS	GLOBAL POSITIONING SYSTEM	PSIG	POUNDS PER SQUARE INCH GAUGE	x 630	EXISTING SPOT ELEVATION
RV AIR RELEASE VALVE	GV	GATE VALVE	PSL PSV	PEDESTRIAN SIGNAL LIGHT PRESSURE SUSTAINING VALVE	77/777/77	
SME AMERICAN SOCIETY OF MECHANICAL ENGINEERS	<u>H</u>		PT	POINT		TO BE DEMOLISHED AND/OR REMOVED
SSY ASSEMBLY STM AMERICAN SOCIETY FOR TESTING	Н	HEIGHT	PVC	POLYVINYL CHLORIDE	***	LIMITS OF GRADING
AND MATERIALS	HB HDOT	HOSE BIBB HAWAII DEPARTMENT OF	<u>R</u>			CONCRETE
VWA AMERICAN WATER WORKS ASSOCIATION		TRANSPORTATION	R	RADIUS	Δ ₄	CONCRETE
	HDPE HGT	HIGH DENSITY POLYETHYLENE HEIGHT	RC RCP RCRA	REINFORCED CONCRETE REINFORCED CONCRETE PIPE		ROCK OUTCROP
воттом	HORIZ HP	HORIZONTAL HORSEPOWER	RCRA	RESOURCE CONSERVATION AND		NATURAL GROUND OR FINISHED GRADE
BOTTOM OF CONCRETE BACK FLOW PREVENTER	HR	HOUR	RD	RECOVERY ACT ROUND OR ROAD		
BUTTERFLY VALVE	HTCO HWY	HAWAIIAN TELCOM COMPANY HIGHWAY	REF REQD	REFERENCE OR REFER REQUIRED	630	FINISHED GRADE CONTOURS
DG BUILDING K BLOCK	HYD	HYDRANT	RESIL	RESILIENT	amonaccininamica 632 americanicacionicanica	EXISTING GROUND CONTOURS (SCREENED)
M BEAM OR BENCHMARK	I		REV ROW	REVISION RIGHT OF WAY		EXISTING DRAINLINE
MP BEST MANAGEMENT PRACTICES DT BOTTOM		INTERNATIONAL BUILDING CODE	RT	RIGHT	147	EXIOTINO DIVANALINE
S BOOSTER PUMP STATION IR BUILT UP ROOF	IBC ICV	IRRIGATION CONTROL VALVE	R/W	RIGHT OF WAY	антинистиратический карами W _в подоставления невысования	EXISTING WATERLINE WITH SIZE
BUTTERFLY VALVE	ID	INSIDE DIAMETER OR INTERNAL DIMENSION	<u>S</u>			EXISTING WATER METER
V BOTTOM WALL	IN	INCH	S	SEWER, SOUTH, OR SLOPE		EVICTING (CODEENED)
	INV IPT	INVERT INTERNATIONAL PIPE THREAD	SCH SDMH	SCHEDULE STORM DRAIN MANHOLE	часаятся п. (и ВПН) по сейтногран (ил Неговогия пад депоном выположенную постоя до стоям выположения по	EXISTING (SCREENED)
	IRRG	IRRIGATION	SHT SK	SHEET SACK	SLOPE	SLOPE
ATV CABLE TELEVISION B CATCH BASIN	<u>J</u>		SL	SLOPE OR STREET LIGHT		APPROXIMATE DIRECTION OF ASSUMED SUF
R CODE OF FEDERAL REGULATIONS	J	JUNCTION	SLB SMH	STREET LIGHT BOX SEWER MANHOLE		RUNOFF DRAINAGE FLOW
CAST IRON CAST IRON PIPE	K		SPECS	SPECIFICATIONS		LAVA TREE MOLD
CHLORINE, CHAIN LINK, CLASS, CENTERLINE OR CLEARANCE			SP. G. SQ	SPECIFIC GRAVITY SQUARE		
F CHAIN LINK FENCE	KVA	KILOVOLT AMP	SS ST	STAINLESS STEEL STATE OR STREET		TREE NAME/TYPE
.G CEILING .R CLEAR	<u>L</u>		STA	STATION		D = approx trunk diameter S = approx spread
IU CONCRETE MASONRY UNIT	L	LENGTH OR LITER	STD STL	STANDARD OR STORM DRAINS STEEL		H = approx height
DMB COMBINATION	LB(S)	POUND OR POUND(S) LINEAR FEET	STRUCT	STRUCTURAL		
ONC CONCRETE ONN CONNECTION	LG	LENGTH OR LONG	SY 	SQUARE YARD		
ONT CONTINUED OR CONTINUOUS	LOC LOG	LOCATION LIMITS OF GRADING	<u></u>			
ORP CORPORATION OSA CONTRACTOR OPERATIONS AND STAGING	LT	LEFT	Ι	TOP, TELEPHONE, OR THICKNESS		
AREA	M		TAI TBM	TRAIL ACCESS INFORMATION TEMPORARY BENCHMARK		
OTG CLEAN-OUT TO GRADE OT CST NAIL	MAX	MAXIMUM	TC	TOP OF CONCRETE		
R CENTER VLK CONCRETE WALK	MCC	MOTOR CONTROL CENTER	TEL TEMP	TELEPHONE LINE TEMPERATURE OR TEMPORARY		
CUBIC YARD	MECH MGN	MECHANICAL MAGNETIC NAIL	TERM THK	TERMINATE OR TERMINATION THICK OR THICKNESS		
	MH	MANHOLE	THR'D	THREADED		
DIAMETED OD DDAIN	MIN MISC	MINIMUM, MINUTE MISCELLANEOUS	TMK	TANK TAX MAP KEY		
DIAMETER OR DRAIN DIRECT BURIED	MJ MON	MECHANICAL JOINT MONUMENT	TOP	TOP OF PAVEMENT TOP OF PIPE		
CAB DISABILITY AND COMMUNICATION ACCESS BOARD	MPH	MILES PER HOUR	TS	TOP STEM		
T DETAIL	MSDS MSL	MATERIAL SAFETY DATA SHEETS MEAN SEA LEVEL	TV TW	TOP VALVE TOP WALL		
DRAIN INLET A DIAMETER	MSP	MAGNETIC SPIKE	TYP	TYPICAL		
P(S) DUCTILE IRON PIPE OR DUCTILE IRON PIPES	MSS	MANUFACTURERS STANDARDIZATION SOCIETY	U			
NR DEPARTMENT OF LAND AND NATURAL	N		UG	UNDERGROUND		
RESOURCES I DOWN		NORTH	UP	UTILITY POLE		
VG(S) DRAWING OR DRAWINGS	N NE	NORTH NORTHEAST	UV	ULTRAVIOLET		
VS DEPARTMENT OF WATER SUPPLY VY DRIVEWAY	NEMA	NATIONAL ELECTRICAL MANUFACTURERS ASSOCIATION	<u>V</u>			
	N.C.	NORMALLY CLOSE	٧	VALVE		
	N.O. NO.	NORMALLY OPEN NUMBER	VERT	VERTICAL		
EAST ELEC ELECTRIC(AL)	NPT	NATIONAL PIPE THREAD	\underline{W}			
EACH	NRS NW	NON-RISING STEM NORTHWEST	W	WATER		
EXISTING GRADE J. EXPANSION JOINT	0	•	W/	WITH	REVISION SYM.	DESCRIPTION SHT./OF DATE
ELEVATION, ELBOW	Name and Association of the Control		WL WM	WATER LINE WATER METER	NO.	STATE OF HAWAII
EV ELEVATION	OC OD	ON CENTER OUTSIDE DIAMETER	WMH WV	WATER MANHOLE WATER VALVE	GL S. NIGO.	DEPARTMENT OF LAND AND NATURAL RESO
IST EXISTING V EACH WAY	OF	OVERFLOW OR OUTSIDE FACE	····		Stan	ENGINEERING DIVISION
	O/H OPNG	OVERHEAD OPENING	^		LICENSED PROFESSIONAL FINGINEED	LAVA TREE STATE MONUMENT
	OSHA	OCCUPATIONAL SAFETY AND HEALTH ADMINISTRATION	X-WALK	CROSSWALK	* No. 10772-0 *	TRAIL IMPROVEMENTS
FOUND FLANGE END	OZ	OUNCE	Y		FAWAII US!	ABBREVIATIONS AND LEGEND
FINISHED GRADE			YD	YARD		
FIRE HYDRANT FINISHED			, 0	· · · · · · · ·	The state of the s	DESIGNED: SM SUBMITTED: MS 64/
FLOWLINE, FLANGE					i	DRAWN: YN DATE: DATE
G FLANGE R FLOOR					THIS WORK WAS PREPARED BY ME OR UNDER MY SUPERVISION.	CHECKED: MN SCALE: AS SHOW
FORCE MAIN					APRIL 30, 2018	APPROVED: SHE
D FOUNDATION FEET OR FOOT					EXPIRATION DATE OF THE LICENSE	CHIEF ENGINEER DATE
						CHIEF ENGINEER DATE

GENERAL NOTES

- THE CONTRACTOR SHALL PERFORM APPLICABLE CONSTRUCTION WORK IN ACCORDANCE WITH THE "STANDARD DETAILS FOR PUBLIC WORKS CONSTRUCTION," DATED SEPTEMBER 1984, AS AMENDED, AND "STANDARD SPECIFICATIONS FOR PUBLIC WORKS CONSTRUCTION," DATED SEPTEMBER 1986 OF THE DEPARTMENT OF PUBLIC WORKS, COUNTY OF HAWAII, AND REVISED ORDINANCES, 2005, AS AMENDED, AND "HAWAII STANDARD SPECIFICATIONS FOR ROAD AND BRIDGE CONSTRUCTION," 2005, OF THE DEPARTMENT OF TRANSPORTATION, HIGHWAYS DIVISION, STATE OF HAWAII, AS AMENDED.
- 2. THE UNDERGROUND UTILITY LINES AND/OR STRUCTURES KNOWN TO EXIST BY THE ENGINEER FROM HIS/HER SEARCH OF RECORDS ARE INDICATED ON THE PLANS. UNLESS OTHERWISE NOTED, ALL LOCATIONS OF UNDERGROUND UTILITY LINES AND/OR STRUCTURES ARE APPROXIMATE. THE INFORMATION SHOWN, THEREFORE, MAY OR MAY NOT BE REPRESENTATIVE OF ACTUAL FIELD CONDITIONS. THE UNDERGROUND UTILITY LINES AND/OR STRUCTURES MAY OR MAY NOT BE PRESENT AT THE LOCATIONS SHOWN OR OTHER UNDERGROUND UTILITY LINES AND/OR STRUCTURES NOT SHOWN MAY BE PRESENT. THE CONTRACTOR SHALL VERIFY THE LOCATIONS AND DEPTHS OF THE UNDERGROUND UTILITY LINES AND/OR STRUCTURES AND EXERCISE PROPER CARE WHEN EXCAVATING IN THE AREA. PROTECT EXISTING UTILITIES AT ALL TIMES DURING CONSTRUCTION. ANY DAMAGE TO THEM SHALL BE REPAIRED AND PAID FOR BY THE CONTRACTOR.
- 3. PRIOR TO THE START OF EXCAVATION, THE CONTRACTOR SHALL NOTIFY ALL APPLICABLE AGENCIES AND HAVE THEM LOCATE THEIR RESPECTIVE UTILITY LINES IN THE PROJECT AREA PRIOR TO EXCAVATING. THE CONTRACTOR SHALL BE HELD RESPONSIBLE AND SHALL PAY FOR ALL DAMAGES TO AND MAINTENANCE AND PROTECTION OF EXISTING UTILITIES AND STRUCTURES.
- 4. TOPOGRAPHIC SURVEY WAS CONDUCTED BY INABA ENGINEERING, INC., DATED MAY 8, 2015. BENCHMARK:

BASEPOINT CP-4 (1/2" PIPE-FD)
ELEVATION = 646.20'
REFERENCE DLNR JOB NO. F34C633B, DWG C-3
ASSUMED COORDINATES: 5,000.000 N
5,000.000 E

- 5. EXISTING CONDITIONS AND DIMENSIONS SHOWN ON THE PLANS ARE APPROXIMATE AND OBTAINED FROM TOPOGRAPHIC SURVEY MAP BY INABA ENGINEERING, INC., DATED MAY 8, 2015, FIELD INVESTIGATIONS AND RECORD DRAWINGS. PROSPECTIVE CONTRACTORS SHALL VISIT THE PREMISES AND THOROUGHLY FAMILIARIZE THEMSELVES WITH ALL WORK DETAILS AND CONDITIONS BEFORE SUBMITTING BID. REASONABLE MODIFICATIONS TO INDICATED DIMENSIONS AND ARRANGEMENTS TO SUIT ACTUAL JOB CONDITIONS SHALL NOT CONSTITUTE BASIS FOR REQUESTING OF ADDITIONAL FUNDS FROM THE DLNR.
- 6. PRIOR TO ORDERING MATERIALS AND EQUIPMENT, THE CONTRACTOR SHALL VERIFY ALL EXISTING CONDITIONS, MATERIALS, SIZES AND DIMENSIONS THAT AFFECT HIS/HER WORK. NOTIFY THE DLNR OF ALL DISCREPANCIES IN WRITING AT LEAST TWO (2) WEEKS PRIOR TO PROCUREMENT.
- 7. VERIFY AND CHECK ALL DIMENSIONS AND DETAILS SHOWN ON THE DRAWINGS PRIOR TO THE START OF CONSTRUCTION. ANY DISCREPANCY BETWEEN THE EXISTING UTILITIES AS SHOWN ON THE DRAWINGS AND IN THE GROUND SHALL BE IMMEDIATELY BROUGHT TO THE ATTENTION OF THE DLNR FOR CLARIFICATION. CONTRACTOR SHALL NOT PROCEED WITH ANY FURTHER WORK UNTIL WRITTEN NOTIFICATION IS RECEIVED FROM THE DLNR; OTHERWISE, THE CONTRACTOR WILL BE HELD RESPONSIBLE FOR ANY COST INVOLVED IN CORRECTION OF CONSTRUCTION COMPLETED DUE TO SUCH DISCREPANCIES.
- 8. WHEN EXCAVATION IS ADJACENT TO OR UNDER EXISTING STRUCTURES OR FACILITIES, THE CONTRACTOR SHALL BE RESPONSIBLE FOR PROPERLY SHEETING AND BRACING THE EXCAVATION AND STABILIZING THE EXISTING GROUND TO RENDER IT SAFE AND SECURE FROM POSSIBLE SLIDES, CAVE-INS AND SETTLEMENT, AND FOR PROPERLY SUPPORTING EXISTING STRUCTURES AND FACILITIES WITH BEAMS, STRUTS OR UNDERPINNING TO FULLY PROTECT IT FROM DAMAGE.
- 9. BACKFILL SHALL BE SANDY OR GRANULAR MATERIAL RAMMED WITH PROPER TOOLS UNTIL COMPACTED FROM 90% TO 95% OF ITS MAXIMUM DENSITY.
- 10. DURING GRADING, BASE COURSE MATERIALS SHALL BE COMPACTED WITH PROPER TOOLS TO 90% TO 95% OF ITS MAXIMUM DENSITY.
- 11. ALL WORK CALLED FOR ON THE PLANS AND NOT ITEMIZED IN THE PROPOSAL AND ALL WORK NOT CALLED FOR BUT REQUIRED FOR THE CONSTRUCTION OF THIS PROJECT, SHALL BE CONSIDERED INCIDENTAL AND INCLUDED IN THE CONTRACTOR'S BID PRICE.

- 12. CONSTRUCTION AREAS ARE LOCATED ALONG A TRAIL. THERE IS NO VEHICULAR ACCESS TO THE CONSTRUCTION AREAS. CONTRACTOR SHALL COORDINATE WITH THE ENGINEER AND SHALL NOT USE LARGE, HEAVY MACHINERY FOR CONSTRUCTION. THE CONTRACTOR SHALL RESTORE TO THEIR ORIGINAL OR BETTER CONDITION ALL IMPROVEMENTS DAMAGED AS A RESULT OF THE CONSTRUCTION, INCLUDING PAVEMENTS, EMBANKMENT, LANDSCAPING, STRUCTURES, UTILITIES, ETC. UNLESS PROVIDED FOR SPECIFICALLY IN THE PROPOSAL, DEMOLITION AND RESTORATION OF EXISTING ITEMS SHALL BE INCIDENTAL AND INCLUDED WITHIN THE CONTRACTOR'S BID PRICE.
- 13. PAYMENT FOR RESTORATION OF PAVEMENT AND OTHER CONCRETE STRUCTURES WILL NOT BE MADE DIRECTLY BUT SHALL BE INCLUDED IN THE CONTRACTOR'S BID PRICE IN THE VARIOUS ITEMS OF THE BID.
- 14. THE CONTRACTOR SHALL BE RESPONSIBLE FOR CONFORMANCE WITH THE APPLICABLE PROVISIONS OF CHAPTER 54, "WATER QUALITY STANDARDS," AND CHAPTER 55, "WATER POLLUTION CONTROL," OF TITLE 11, ADMINISTRATIVE RULES OF THE STATE DEPARTMENT OF HEALTH.
- 15. THE CONTRACTOR SHALL PROVIDE TO THE DLNR "AS-BUILT" DRAWINGS OF ALL NEW IMPROVEMENTS UPON COMPLETION OF WORK.
- 16. NON-COMPLIANCE TO ANY OF THE CONTRACT REQUIREMENTS SHALL MEAN IMMEDIATE SUSPENSION OF ALL WORK, AND REMEDIAL WORK SHOULD COMMENCE IMMEDIATELY. ALL COSTS INCURRED AS A RESULT OF THE CONTRACTOR'S NON COMPLIANCE SHALL BE BILLED TO THE CONTRACTOR. FURTHERMORE, VIOLATORS SHALL BE SUBJECTED TO ADMINISTRATIVE, CIVIL AND/OR CRIMINAL PENALTIES.
- 17. THE CONTRACTOR SHALL OBSERVE AND COMPLY WITH ALL FEDERAL, STATE AND LOCAL LAWS REQUIRED FOR THE PROTECTION OF PUBLIC HEALTH, SAFETY AND ENVIRONMENTAL QUALITY AND FOR WORKER PROTECTION.
- 18. ALL EXISTING UTILITIES, SERVICE LINES, SUPPLY LINES AND COMMUNICATION LINES SHALL REMAIN IN PLACE AND IN SERVICE THROUGHOUT THE TERM OF THE PROJECT. IF RELOCATION OF EXISTING FACILITIES IS REQUIRED FOR THE CONTRACTOR'S CONVENIENCE, INTERRUPTION OF SERVICE SHALL BE KEPT TO A MINIMUM AND SHALL BE DONE AT THE CONTRACTOR'S EXPENSE AND ONLY WITH THE APPROVAL OF THE DLNR.
- 19. THE CONTRACTOR SHALL PROVIDE CONTINUOUS SAFE ACCESS TO AND FROM ALL DRIVEWAYS AND STREETS.
- 20. THE CONTRACTOR SHALL SECURE ALL NECESSARY LICENSES, PERMITS, APPROVALS AND CLEARANCES, AND SHALL PAY ALL APPLICATIONS, LICENSES, PERMITS AND INSPECTION FEES REQUIRED FOR THE WORK AND SHALL GIVE ALL NOTICES NECESSARY FOR AND INCIDENTAL TO THE PROPER AND LAWFUL EXECUTION OF THE WORK.
- 21. THE CONTRACTOR SHALL MAINTAIN VEHICULAR AND PEDESTRIAN ACCESS TO THE SITE DURING NON WORKING HOURS.
- 22. LAVA TREE STATE MONUMENT SHALL WILL REMAIN OPEN TO THE PUBLIC AND FULLY OPERATIONAL DURING CONSTRUCTION. THE CONTRACTOR SHALL INSTALL ADEQUATE TEMPORARY BARRICADES AND WARNING SIGNS TO PROTECT THE PUBLIC DURING CONSTRUCTION. THE CONTRACTOR SHALL ENSURE THAT THE PUBLIC PARKING AREA, VEHICULAR ACCESS AND PEDESTRIAN WAYS REMAIN UNOBSTRUCTED AND SAFE DURING THE CONSTRUCTION PERIOD. ANY RESTRICTIONS TO PUBLIC ACCESS SHALL BE COORDINATED WITH THE ENGINEER AT LEAST TEN (10) WORKING DAYS IN ADVANCE.
- 23. THE CONTRACTOR AGREES THAT HE/SHE SHALL ASSUME SOLE AND COMPLETE RESPONSIBILITY FOR THE JOB SITE CONDITIONS DURING THE COURSE OF CONSTRUCTION OF THIS PROJECT, INCLUDING THE SAFETY OF ALL PERSONS AND PROPERTY; AND THAT THIS REQUIREMENT SHALL APPLY CONTINUOUSLY AND NOT BE LIMITED TO NORMAL WORKING HOURS; AND THAT THE CONTRACTOR SHALL DEFEND, INDEMNIFY AND HOLD THE STATE AND COUNTY OF HAWAII HARMLESS FROM ANY AND ALL LIABILITY, REAL OR ALLEGED, IN CONNECTION WITH THE PERFORMANCE OF WORK ON THIS PROJECT, EXCEPT FOR LIABILITY ARISING FROM THE SOLE NEGLIGENCE OF THE STATE.
- 24. THE CONTRACTOR SHALL PROVIDE, INSTALL AND MAINTAIN ALL NECESSARY SIGNS, LIGHTS, FLARES, BARRICADES, MARKERS, CONES, AND OTHER PROTECTIVE FACILITIES, AND SHALL TAKE ALL NECESSARY PRECAUTIONS FOR THE PROTECTION, CONVENIENCE AND SAFETY OF THE PUBLIC.
- 25. SHOULD HAZARDOUS MATERIAL BE ENCOUNTERED, THE ENGINEER SHALL BE NOTIFIED AND ALL WORK SHALL BE SUSPENDED UNTIL THE MATERIAL IS PROPERLY REMEDIATED, HANDLED AND DISPOSED OF OFF-SITE IN ACCORDANCE WITH ALL APPLICABLE REGULATIONS AND REQUIREMENTS.
- 26. THE CONTRACTOR SHALL PROVIDE TEMPORARY SECURITY COVERS OVER ANY AND ALL OPENINGS CREATED AS A CONSEQUENCE OF THE PROJECT WORK.

- 27. THE CONTRACTOR SHALL SUBMIT A CONSTRUCTION SCHEDULE, IDENTIFYING START AND FINISH OF EACH MAJOR TASK, INCLUDING ANY UTILITY SERVICE OUTAGES AND PUBLIC ACCESS DISRUPTIONS TO THE PARK. THE WORK SHALL BE SEQUENCED TO MINIMIZE INTERRUPTION OF UTILITY SERVICE AND/OR PUBLIC ACCESS TO THE PARK. SUBMIT SCHEDULE IN BOTH MICROSOFT PROJECT 2010 (OR LATER VERSION) AND ADOBE ACROBAT FORMATS TO THE DLNR AT LEAST TEN (10) DAYS PRIOR TO START OF WORK. OUTAGES AND PUBLIC ACCESS DISRUPTIONS SHALL BE APPROVED BY THE DLNR.
- 28. IF A LAVA TUBE OR INADVERTENT CULTURAL OR HISTORIC FINDS ARE ENCOUNTERED, STOP WORK IMMEDIATELY AND NOTIFY THE STATE HISTORIC PRESERVATION DIVISION AT 808.692.8015 AND THE ENGINEER. FOR HUMAN REMAINS/BURIALS, THE HAWAII POLICE DEPARTMENT SHALL ALSO BE CONTACTED AT 808.935.3311 OR 808.961,2252.
- 29. THE CONTRACTOR SHALL CALL THE HAWAII ONE-CALL CENTER AT 1.866.423.7287 PRIOR TO EXCAVATION TO ENSURE THAT ALL UNDERGROUND UTILITIES WITHIN DISTURBED AREAS ARE MARKED AND THAT NO LINES ARE IN THE WAY.
- 30. APPROXIMATE EARTHWORK QUANTITIES ARE:

EXCAVATION: 10 CY
FILL: 34 CY
GRADED AREA: 1846 SF


31. THE CONTRACTOR SHALL NOT PERFORM ANY CONSTRUCTION ACTIVITY THAT DIRECTLY OR INDIRECTLY RESULTS IN SOIL AND DEBRIS IN ANY FORM TO FALL, SLIDE OR FLOW ONTO ADJOINING PROPERTIES, STREETS OR NATURAL WATER COURSES. SHOULD SUCH VIOLATIONS OCCUR, THE COST INCURRED FOR ANY REMEDIAL ACTION BY THE ENGINEER SHALL BE PAYABLE BY THE CONTRACTOR.

DISABILITY AND COMMUNICATION ACCESS BOARD (DCAB) NOTE

THIS PROJECT SHALL MEET THE ACCESSIBILITY REQUIREMENTS AS DEFINED IN THE PROPOSED HAWAII OUTDOOR DEVELOPED AREA ACCESSIBILITY GUIDELINES (HODAAG).

GRADING NOTES

- 1. THE CONTRACTOR SHALL REMOVE ALL SILT AND DEBRIS DEPOSITED IN DRAINAGE FACILITIES, ROADWAYS, AND OTHER AREAS RESULTING FROM HIS/HER WORK. THE COSTS INCURRED FOR ANY NECESSARY REMEDIAL ACTION BY THE STATE SHALL BE PAYABLE BY THE CONTRACTOR.
- 2. THE CONTRACTOR, AT HIS/HER OWN EXPENSE, SHALL KEEP THE PROJECT AND SURROUNDING AREAS FREE FROM DUST NUISANCES. THE WORK SHALL BE IN CONFORMANCE WITH THE AIR POLLUTION CONTROL RULES OF THE STATE DEPARTMENT OF HEALTH.
- 3. ALL GRADING OPERATIONS SHALL BE PERFORMED IN CONFORMANCE WITH THE APPLICABLE PROVISIONS OF THE HAWAII ADMINISTRATIVE RULES, TITLE 11, CHAPTER 54, "WATER QUALITY STANDARDS," AND CHAPTER 55, "WATER POLLUTION CONTROL," AND TO THE EROSION AND SEDIMENTATION CONTROL STANDARDS AND GUIDELINES OF THE DEPARTMENT OF PUBLIC WORKS.
- 4. THE CONTRACTOR SHALL SOD, PLANT OR HYDROMULCH ALL SLOPES AND EXPOSED AREAS IMMEDIATELY AFTER THE GRADING WORK HAS BEEN COMPLETED.
- 5. THE CONTRACTOR SHALL INFORM THE ENGINEER OF THE LOCATION OF THE DISPOSAL AND/OR BORROW SITE(S) REQUIRED FOR THIS PROJECT WHEN AN APPLICATION FOR A GRADING PERMIT IS MADE. THE DISPOSAL AND/OR BORROW SITE(S) MUST ALSO FULFILL THE REQUIREMENTS OF THE GRADING ORDINANCE.
- 6. NO GRADING WORK SHALL BE DONE ON SATURDAYS, SUNDAYS AND HOLIDAYS ANYTIME WITHOUT PRIOR APPROVAL FROM THE STATE. GRADING WORK ON NORMAL WORKING DAYS SHALL BE BETWEEN THE HOURS OF 7:00 AM AND 3:30 PM.
- 7. FILLS SHALL BE PLACED IN HORIZONTAL LAYERS NOT MORE THAN 8" IN LOOSE THICKNESS, MOISTEN AS REQUIRED, AND COMPACTED TO NOT LESS THAN 95 PERCENT RELATIVE DENSITY.
- 8. THE CONTRACTOR SHALL REMOVE ALL VEGETATION BEFORE PLACING FILLS ON NATURAL GROUND SURFACE.
- 9. THE LIMITS OF GRADED AREA SHALL BE FLAGGED BEFORE THE COMMENCEMENT OF THE GRADING WORK.
- 10. GRADING SHALL BE CONSIDERED INCIDENTAL TO THE CONSTRUCTION AND INSTALLATION OF PROJECT FACILITIES.
- 11. ALL STABILIZED AND GRADED AREAS SHALL BE IN ACCORDANCE WITH THE PROJECT SPECIFICATIONS.
- 12. THE CONTRACTOR SHALL PAY FOR ALL COSTS INCURRED FOR THIS WORK. NO EXTRAS WILL BE CONSIDERED FOR MAINTENANCE PERIOD EXCEEDING SIXTY (60) DAYS.
- 13. TO ALLOW FOR TOPSOIL, CUT AREAS SHALL BE OVEREXCAVATED BY SIX (6) INCHES AND FILL AREAS SHALL BE STOPPED SIX (6) INCHES BELOW GRADES SHOWN.

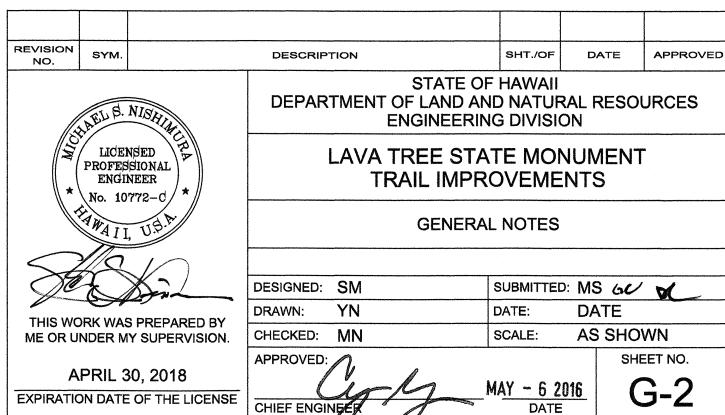



SHEET NO.

3 OF 14 SHEETS

JOB NO. J00CF34B

PROJECTS/HAWAII, STATE OF (HIW146833 ADA 1 AVA TRFE STATE

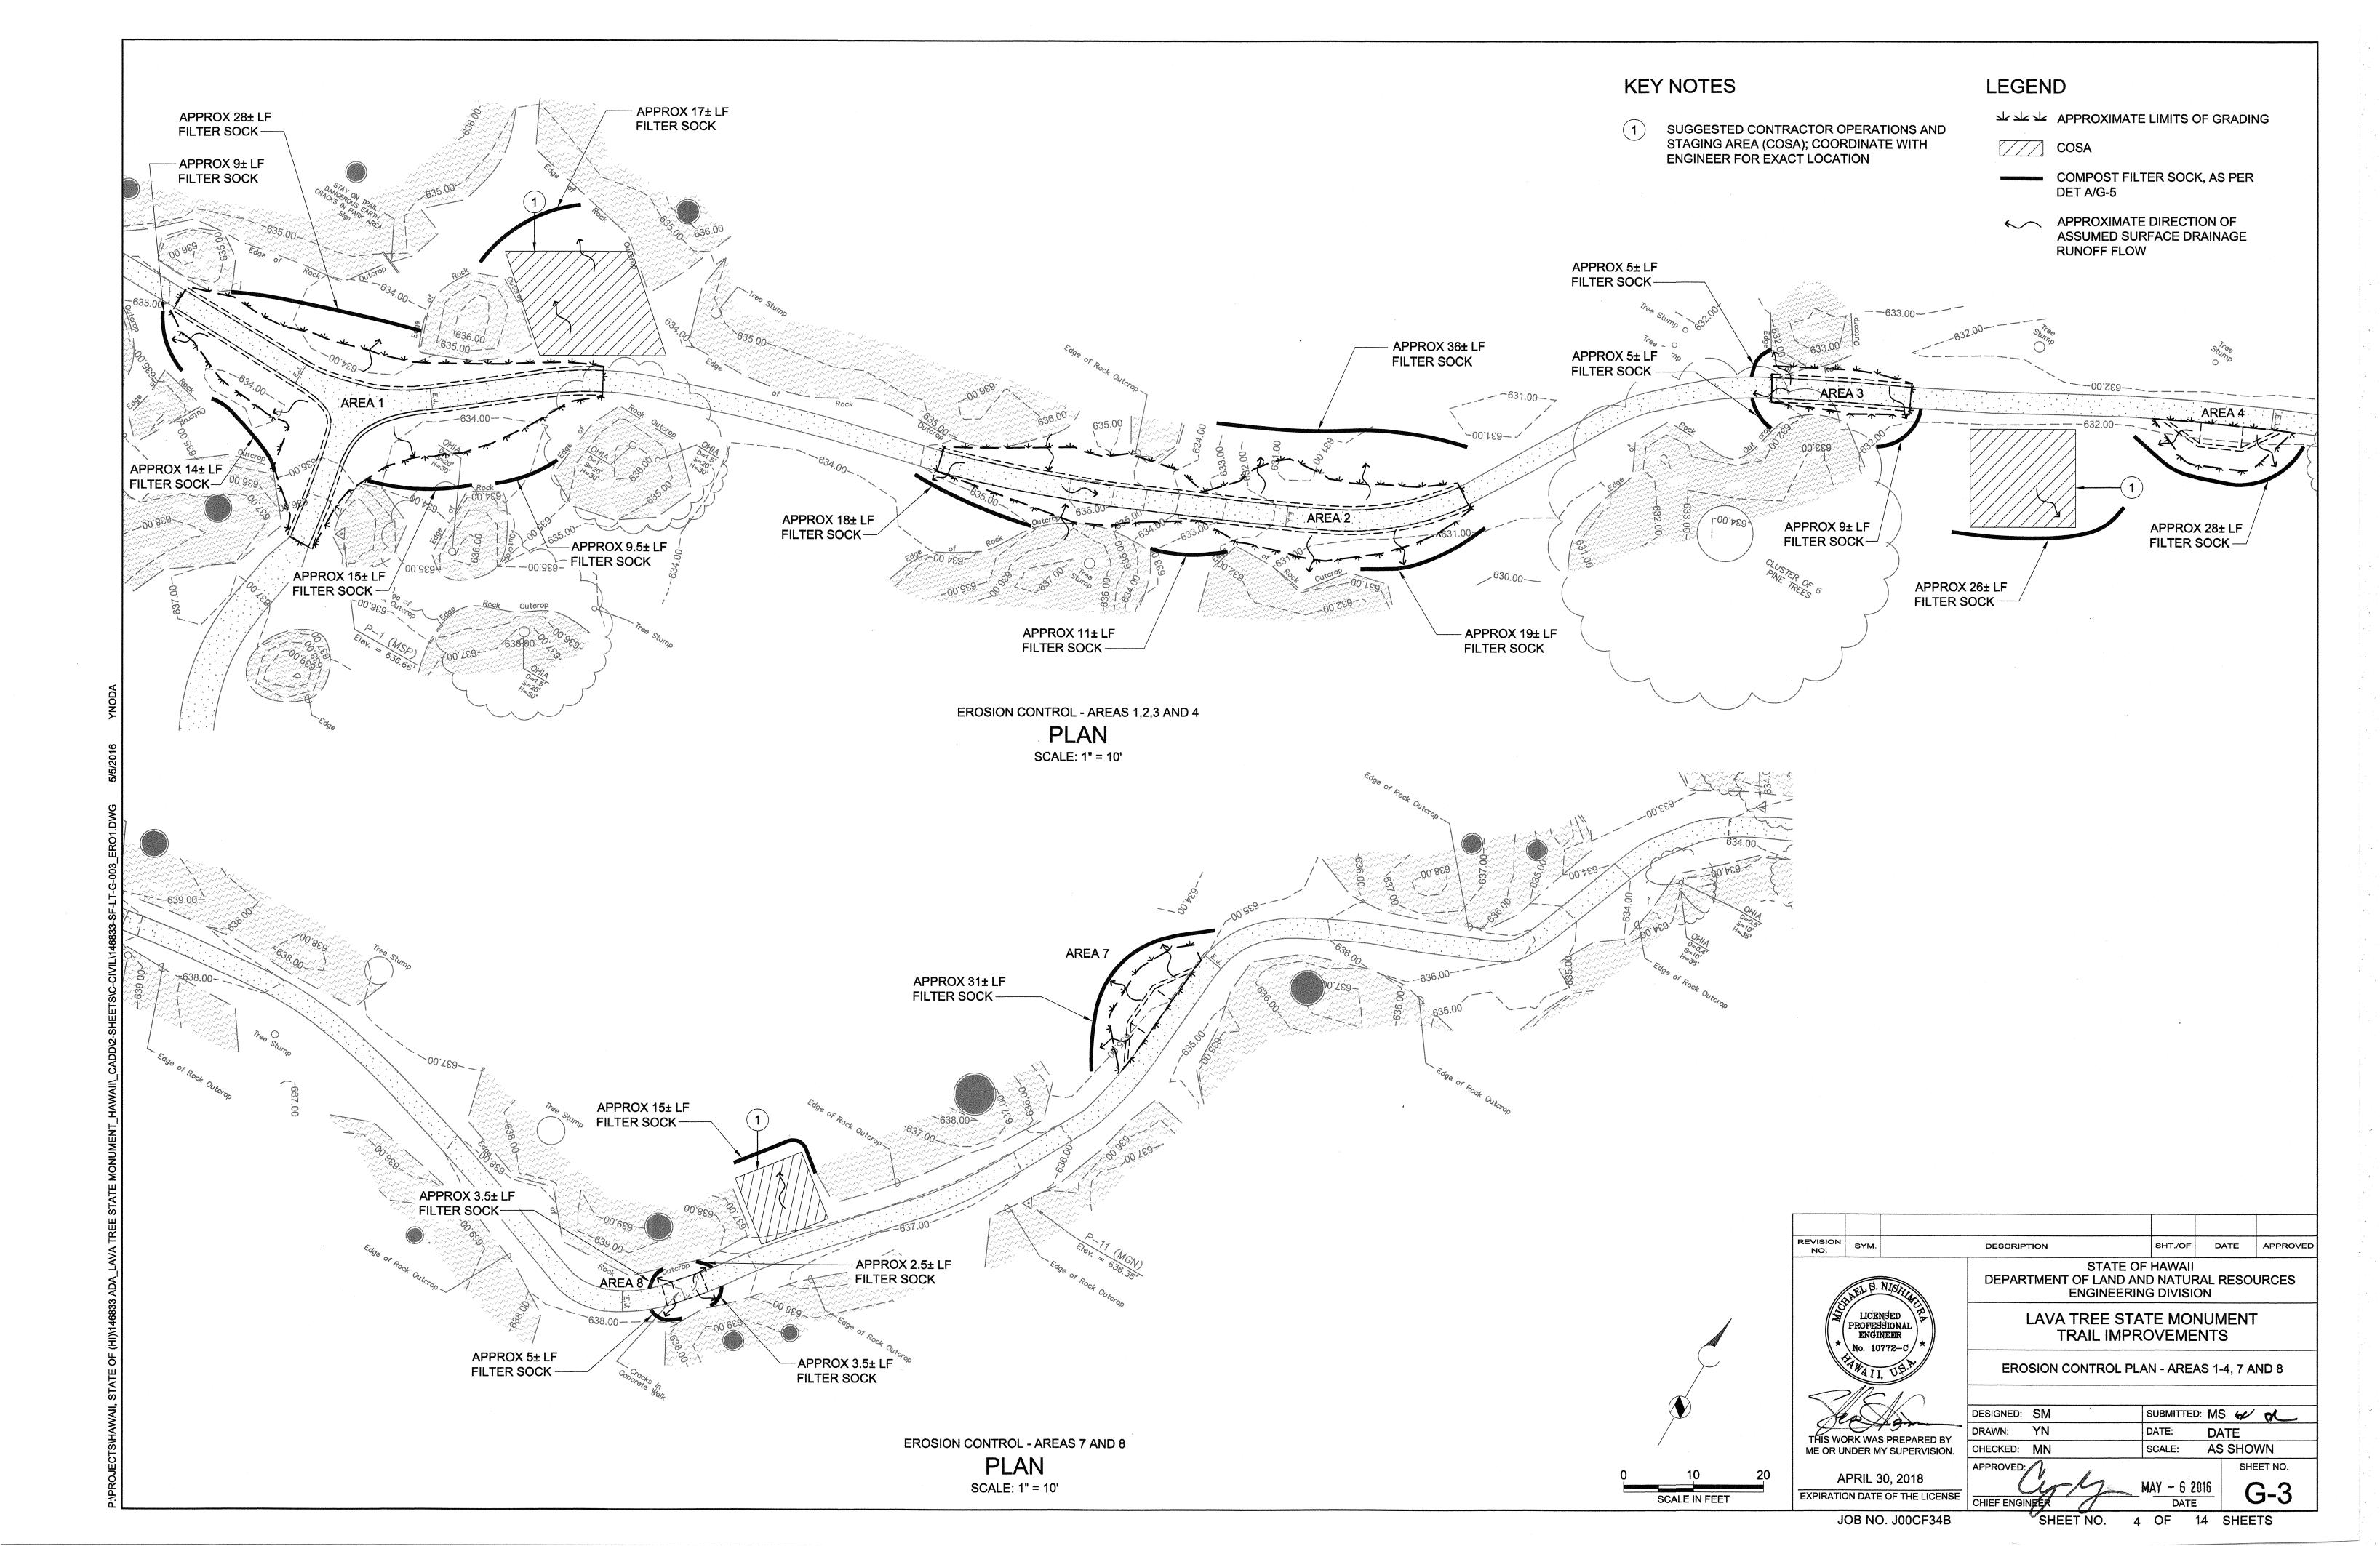

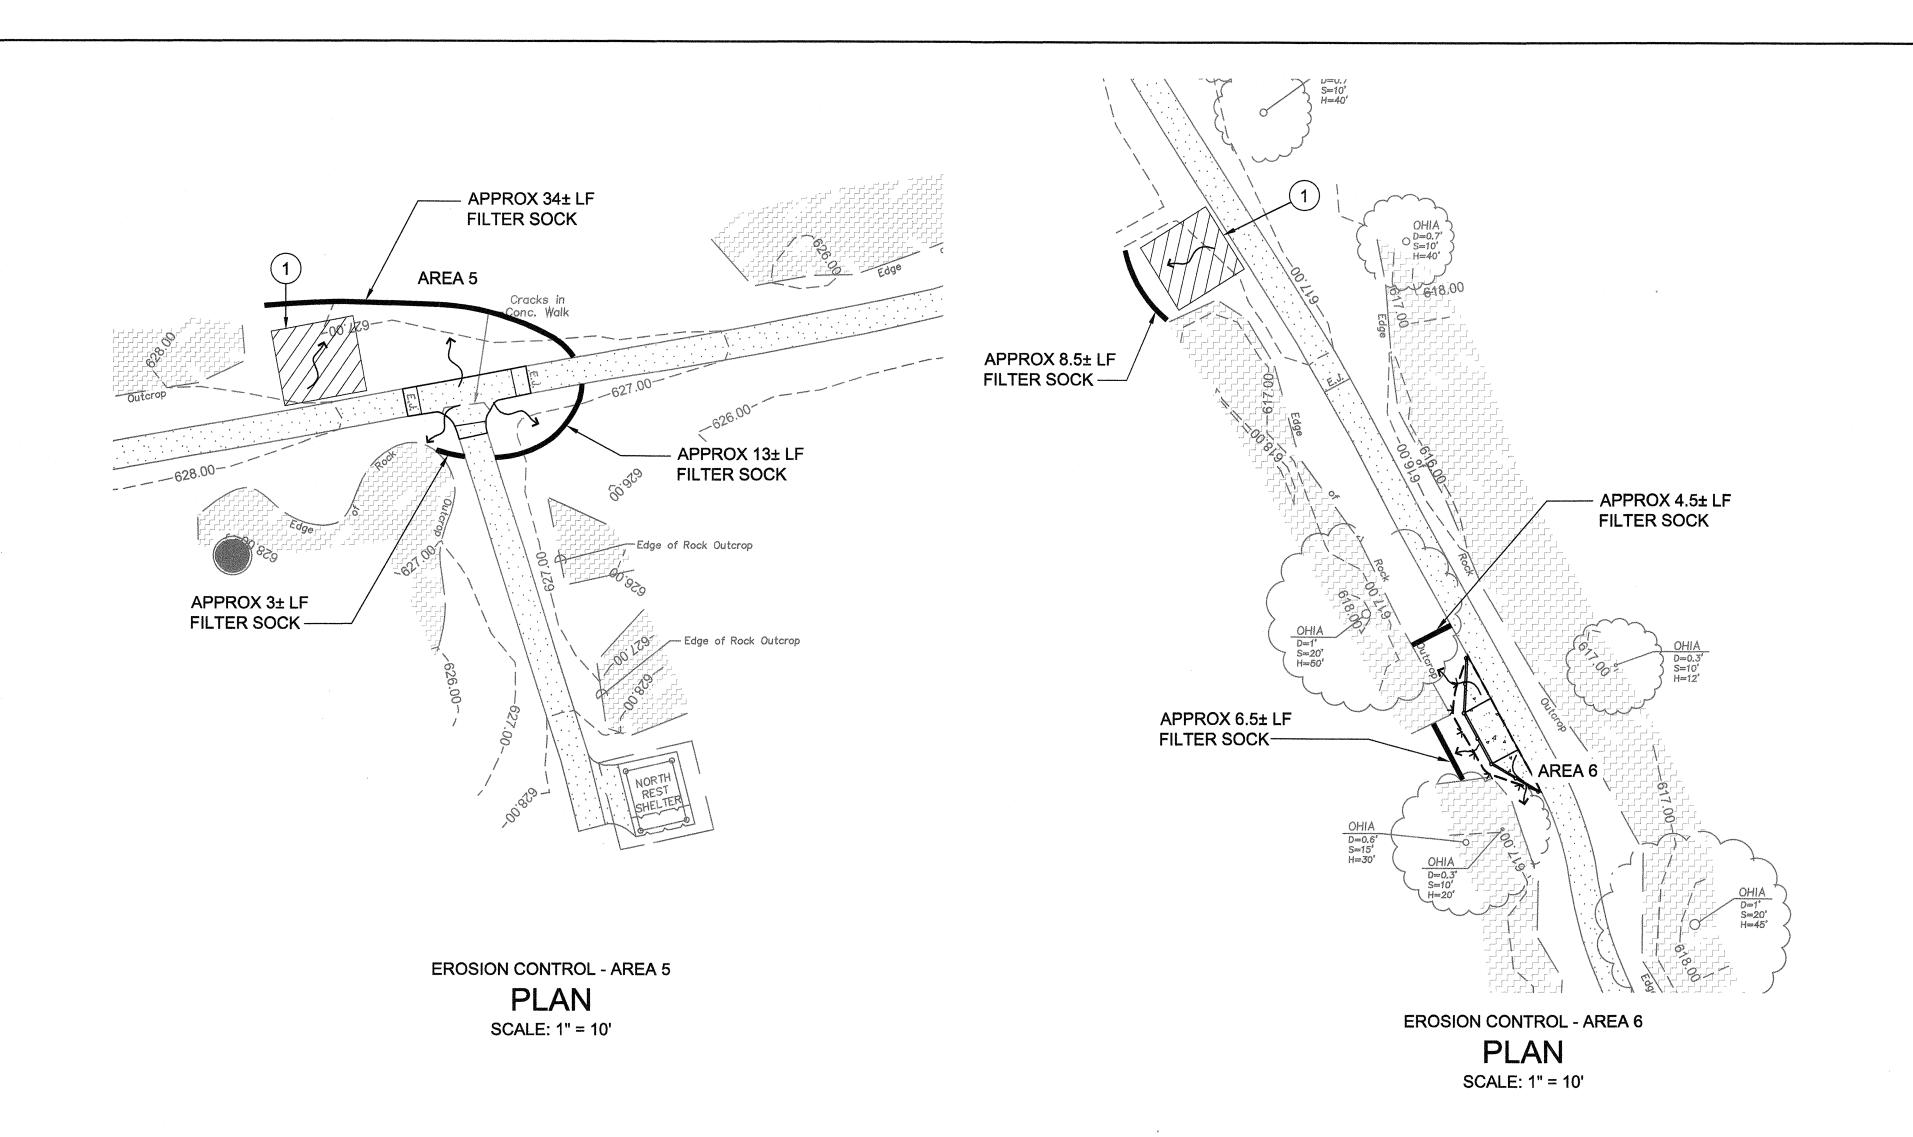

KEY NOTES

SUGGESTED CONTRACTOR OPERATIONS AND STAGING AREA (COSA); COORDINATE WITH ENGINEER FOR EXACT LOCATION


LEGEND


ムトト APPROXIMATE LIMITS OF GRADING

COMPOST FILTER SOCK, AS PER DET A/G-5

COSA

APPROXIMATE DIRECTION OF ASSUMED SURFACE DRAINAGE **RUNOFF FLOW**

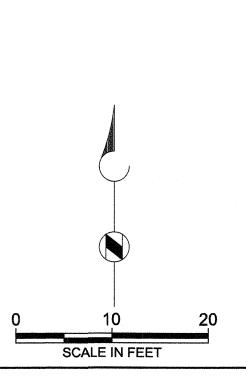

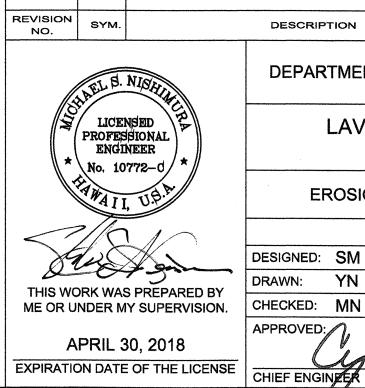

LAVA TREE STATE MONUMENT TRAIL IMPROVEMENTS EROSION CONTROL PLAN - AREAS 5 AND 6

DESCRIPTION

STATE OF HAWAII DEPARTMENT OF LAND AND NATURAL RESOURCES ENGINEERING DIVISION


SUBMITTED: MS GU M DESIGNED: SM DRAWN: YN DATE CHECKED: MN SCALE: AS SHOWN SHEET NO. MAY - 6 2016

SHEET NO. 5 OF 14 SHEETS


JOB NO. J00CF34B

SHT./OF DATE APPROVED

- NOTES:
- 10"-DIA COMPOST FILTER SOCKS SHALL BE SILTSOXX BY FILTERXX, BIOSOCK BY ENVIROTECH BIOSOLUTIONS, OR APPROVED EQUAL.
- THE COMPOST FILTER SOCK SHALL BE INSPECTED AT LEAST ONCE PER WEEK AND AFTER EACH RAINFALL EVENT: MAKE REPAIRS AS NEEDED. OR AS DIRECTED BY THE ENGINEER.
- IF THE COMPOST FILTER SOCK BECOMES CLOGGED WITH SEDIMENT SO THAT IT NO LONGER ADEQUATELY PERFORMS ITS FUNCTION, THE COMPOST FILTER SOCK SHALL BE REMOVED. CLEANED AND REPLACED.
- DISPOSE OF SILT, SEDIMENT AND DEBRIS AFTER EACH EVENT, WHEN SEDIMENT ACCUMULATION REACHES THREE-QUARTERS OF THE BARRIER HEIGHT, OR AS DIRECTED BY THE ENGINEER.

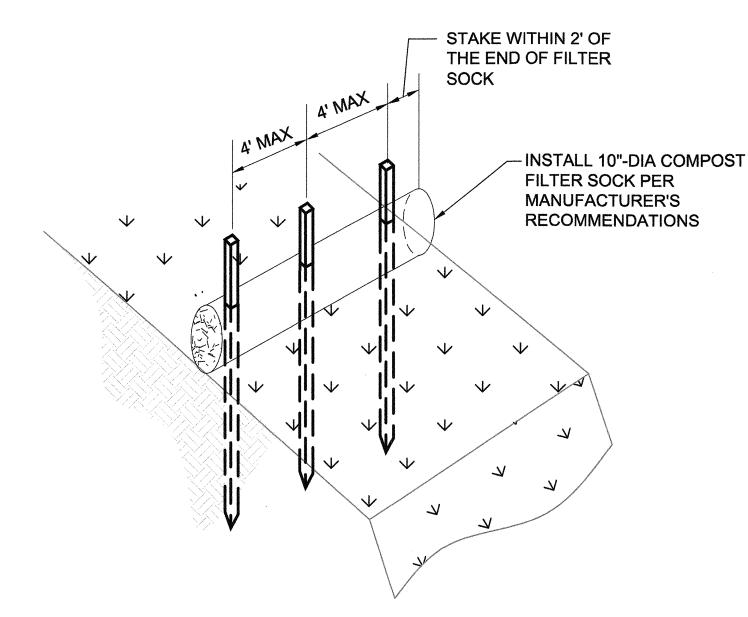

STAKE REQUIRED						
SOCK LENGTH	STAKES REQUIRED					
(FT)	FOR EACH SOCK					
25	8					
20	6					
12	4					

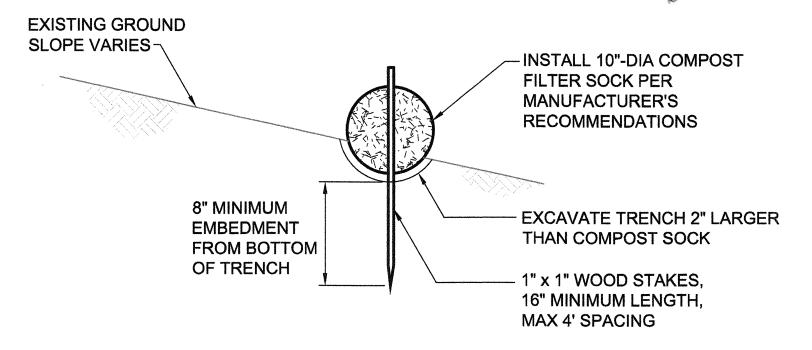

ENTRENCHING AND STAKING DETAILS




DETAIL

NOT TO SCALE

COMPOST FILTER SOCK

EROSION AND SEDIMENT CONTROL NOTES AND BMP REQUIREMENTS

- 1. THE CONTRACTOR SHALL TRAIN HIS/HER EMPLOYEES AND SUBCONTRACTORS ON THE SOIL EROSION AND SEDIMENT CONTROL BMPS.
- 2. A SPECIFIC INDIVIDUAL APPOINTED BY THE CONTRACTOR SHALL BE DESIGNATED TO BE RESPONSIBLE FOR SOIL EROSION AND SEDIMENT CONTROL BMPS ON THIS PROJECT.
- 3. THE CONTRACTOR SHALL NOTIFY THE ENGINEER OF THE PERSONS RESPONSIBLE FOR THE INSPECTION, MAINTENANCE AND REPAIR OF THE SOIL EROSION AND SEDIMENT CONTROL BMPS.
- 4. AN INSPECTION AND MAINTENANCE REPORT SHALL BE GENERATED FOR EACH INVESTIGATION, AND THE REPORTS KEPT ON FILE.
- 5. WHERE APPLICABLE AND FEASIBLE, THE BMPS TO CONTROL SOIL EROSION AND SEDIMENT AND OTHER POLLUTANTS SHALL BE IN PLACE BEFORE ANY CONSTRUCTION ACTIVITIES ARE INITIATED AND SHALL BE PROPERLY CONSTRUCTED AND MAINTAINED THROUGHOUT THE CONSTRUCTION PERIOD.
- 6. BMPS SHALL BE EMPLOYED AT ALL TIMES TO THE MAXIMUM EXTENT PRACTICABLE TO PREVENT DAMAGE BY SEDIMENTATION TO STREAMS, WATERCOURSES, NATURAL AREAS AND THE PROPERTY OF OTHERS.
- 7. THE CONTRACTOR SHALL PROVIDE ADDITIONAL SOIL EROSION AND SEDIMENT CONTROL BMPS AS NEEDED WHERE CONTRACTOR TRAVELS OR WORKS BEYOND THE CONSTRUCTION LIMITS.
- 8. IF HEAVY RAINS ARE PROJECTED DURING A WORKDAY, ALL SOIL EROSION AND SEDIMENT CONTROL BMPS THAT ARE A PART OF THIS PROJECT SHALL BE INSPECTED IMMEDIATELY AND REINFORCED AS NECESSARY.
- ALL SOIL EROSION AND SEDIMENT CONTROL BMPS SHALL BE CHECKED AND REPAIRED AS NECESSARY: FOR EXAMPLE, WEEKLY IN DRY PERIODS AND WITHIN TWENTY-FOUR HOURS AFTER ALL RAINFALL OF 0.5 INCHES OR GREATER WITHIN A 24-HOUR PERIOD. DURING PROLONGED RAINFALL. DAILY CHECKING IS NECESSARY. THE CONTRACTOR SHALL MAINTAIN RECORDS OF CHECKS AND REPAIRS.
- 10. USE ROLL-OFF DUMPSTERS AS A TEMPORARY CONTAINER FOR DISPOSAL OF CONSTRUCTION WASTES, AND DEMOLITION WASTES. DUMPSTERS SHALL BE LEAK-PROOF AND SHALL NOT BE OVERFILLED TO THE LEVEL WHERE THEIR COVERS CANNOT BE FULLY SHUT.
- 11. DISPOSAL AREAS SHALL NOT BE CLOSE TO THE DIRECTION OF STORMWATER RUNOFF INTO ANY RECEIVING STATE WATER.
- 12. GOOD HOUSEKEEPING SHALL BE UTILIZED TO ENSURE PROTECTION OF PEDESTRIAN AND VEHICULAR ACCESS WAYS FROM MUD, DIRT AND DEBRIS.
- 13. THE CONTRACTOR SHALL ENSURE THAT ALL TIRES OF CONSTRUCTION VEHICLES ARE SUFFICIENTLY CLEANED SO THAT DIRT OR DEBRIS IS NOT TRACKED OFF THE CONSTRUCTION SITE. WASHING OFF TIRES WITH WATER WILL NOT BE ACCEPTABLE UNLESS THE RUNOFF IS CONTAINED AND DOES NOT ENTER THE STORMDRAIN SYSTEM ADJOINING PROPERTIES. OR ONTO THE COUNTY OR STATE RIGHT OF WAY.

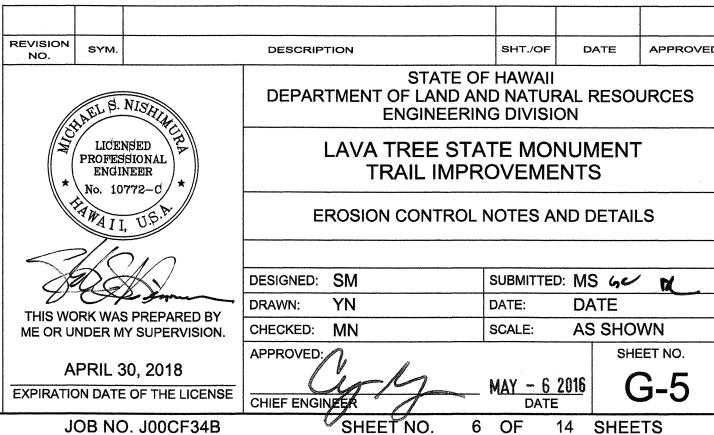

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